
EV CHARGING STATION INSTALLATION

1735 NORTH BISHOP AVE **ROLLA, MO 65401**

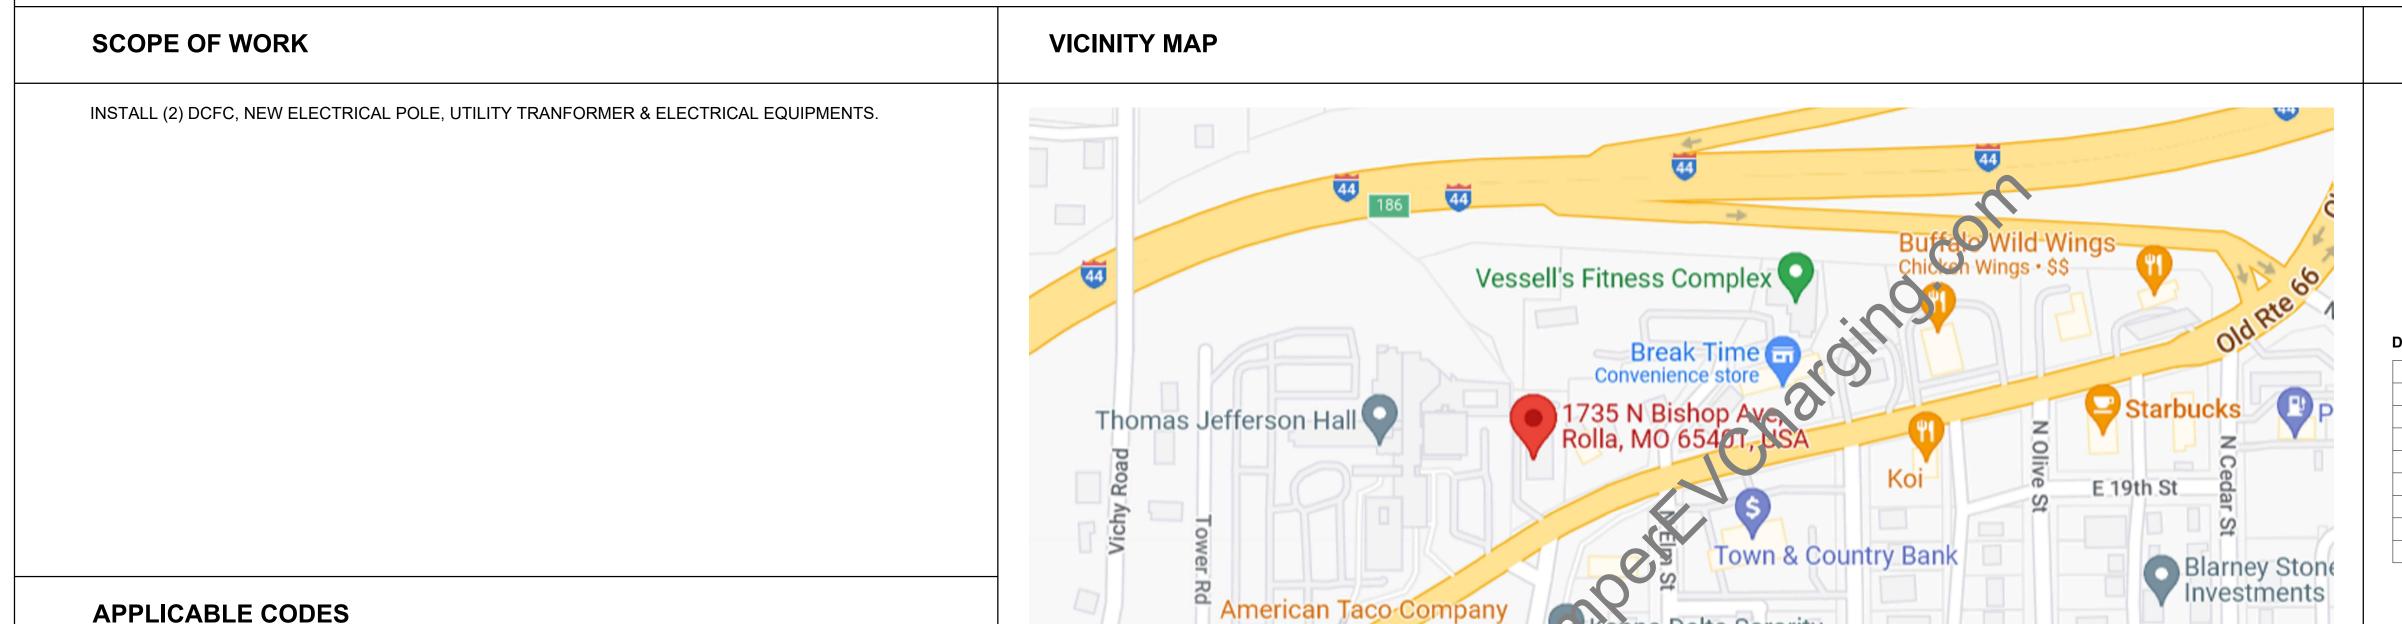


SATELLITE VIEW

westment Realty



SHEET INDEX

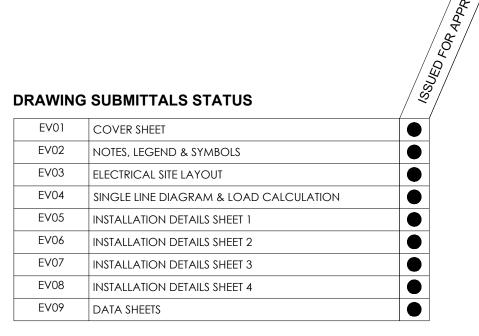

LEGEND	
UPDATED DRAWING ISSUE	•
UNCHANGED	0
DRAWING REMOVED FROM SUBMITTAL	Х

WORK PERFORMED UNDER THIS CONTRACT SHALL, AT A MINIMUM, BE IN CONFORMANCE WITH APPLICABLE NATIONAL, STATE AND LOCAL CODES HAVING JURISDICTION. EQUIPMENT FURNISHED AND ASSOCIATED INSTALLATION WORK PERFORMED UNDER THIS CONTRACT SHALL BE IN STRICT COMPLIANCE WITH CURRENT APPLICABLE CODES ADOPTED BY THE LOCAL AHJ, INCLUDING ANY AMENDMENTS AND STANDARDS AS SET FORTH BY THE FOLLOWING:

- 2018 INTERNATIONAL BUILDING CODE (IBC)
- 2015 INTERNATIONAL EXISTING BUILDING CODE (IEBC)
- 2009 INTERNATIONAL ENERGY CONSERVATION CODE (IECC)
- NATIONAL ELECTRICAL CODE 2017 (NEC)

WHERE THE CONTRACT DOCUMENTS EXCEED THE REQUIREMENTS OF THE REFERENCED CODES, STANDARDS, ETC., THE CONTRACT DOCUMENTS SHALL TAKE PRECEDENCE. WHERE CONFLICTS BETWEEN VARIOUS CODES, ORDINANCES, RULES, AND REGULATIONS EXIST, COMPLY WITH THE MOST STRINGENT. PROMPTLY BRING ALL CONFLICTS OBSERVED BETWEEN CODES, ORDINANCES, RULES, REGULATIONS, REFERENCED STANDARDS, AND THESE DOCUMENTS TO THE ATTENTION OF THE ENGINEER FOR FINAL RESOLUTION. CONTRACTOR WILL BE HELD RESPONSIBLE FOR ANY VIOLATION OF THE LAW.

UNDERGROUND UTILITIES



CALL AT LEAST TWO WORKING

EXISTING UNDERGROUND FACILITIES ARE SHOWN ON THESE PLANS FROM RECORD INFORMATION AND ARE INFORMATION ONLY. OTHER UNDERGROUND FACILITIES NOT SHOWN ON THE PLANS MAY EXIST. THE CONTRACTOR SHALL BE RESPONSIBLE FOR VERIFYING ALL EXISTING UNDERGROUND FACILITIES PRIOR TO CONSTRUCTION. THE CONTRACTOR SHALL NOTIFY A ONE-CALL SERVICE CENTER, TOLL FREE AT 811, NO LESS TWO DAYS PRIOR TO ANY EXCAVATION.

THE ENGINEER OF RECORD SHALL NOT HAVE CONTROL OR CHARGE OF AND SHALL NOT BE RESPONSIBLE FOR CONSTRUCTION MEANS, METHODS, DEVIATIONS, TECHNIQUES,

SEQUENCES, OR PROCEDURES, OR FOR SAFET

FAILURE OF ANY OF THEM TO CARRY OUT TH WORK IN ACCORDANCE WITH THE CONTRACT

THE INFORMATION IN THIS DRAWING IS DISCLOSURE, OR USE THEREOF IS PROHIBITED WITHOUT THE WRITTEN CONSENT OF THE ENGINEER OF RECORD

CONSTRUCTION UNLESS P.E. STAMPED, SIGNED, DATED AND ONE OF THE REVISION STATES "ISSUED FOR CONSTRUCTION", "IFC" OR "IFC UPDATED".

0 01/31/2023 ISSUED FOR APPROVAL REV. DATE

EV CHARGETEC

185 INDUSTRIAL PKWY, BRANCHBURG, NJ 08876

908-801-6890

PROJECT:

EVCS INSTALLATION


1735 NORTH BISHOP AVE ROLLA, MO 65401

AMPER PROJECT NUMBER: SHEET SIZE: DRAWN BY:

24X36 CHECKED BY: DESIGNED BY: DEE

COVER SHEET

EV01

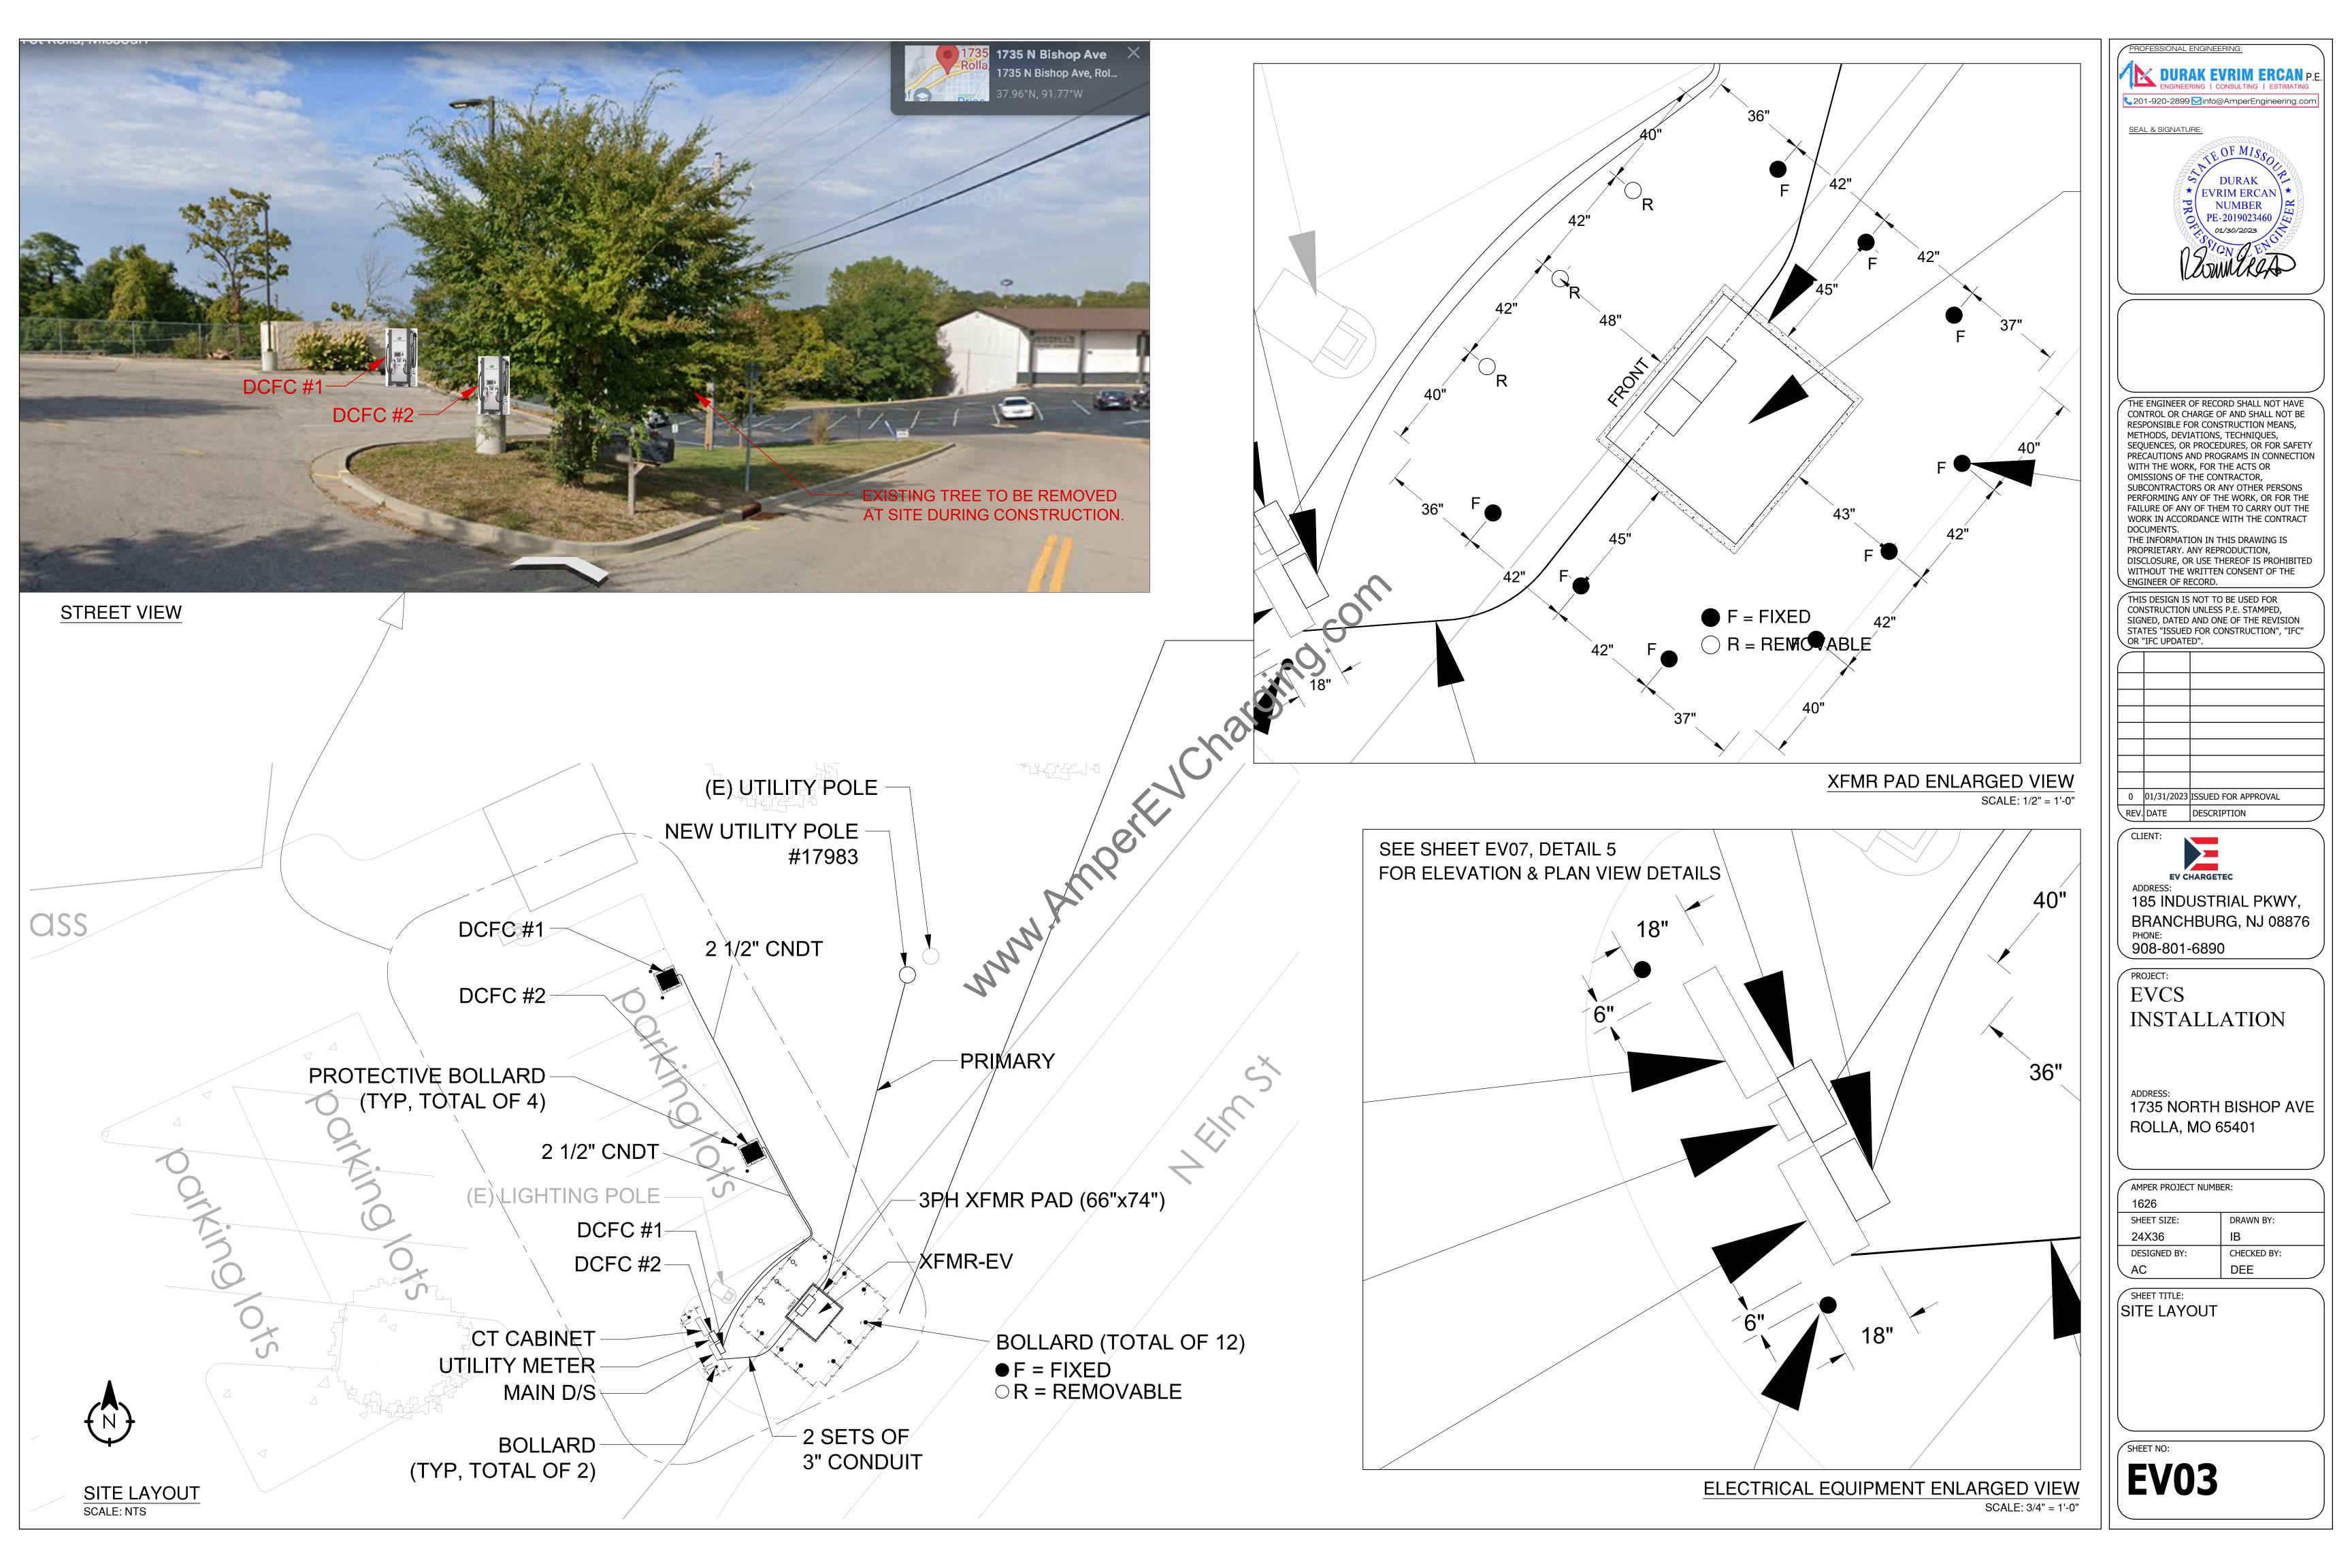

ELECTRICAL LOAD CALCULATION

A) BASED ON THE PRODUCT SPECIFICATION (SEE SHEET EV09 DETAIL 3):

INPUT VOLTAGE: 480VAC (3P+N+PE)
FLA/BREAKER RATING: 160A / 200A
POWER FACTOR: >0.98
POWER: 120KW

- B) CALCULATING TOTAL MAXIMUM DEMAND (KVA):
 - i. DCFC #1 = 120KW x P.F DEMAND LOAD (KVA) = 120 x 0.98 = 117.6KVA x 125% = 147KVA
 - ii. DCFC #2 = 120KW x P.F DEMAND LOAD (KVA) = 120 x 0.98 = 117.6KVA x 125% = 147KVA
 - iii. DCFC #3 (FUTURE LOAD) = 120 x 0.98 = 117.6KVA x 125% 147KVA

TOTAL MAXIMUM DEMAND LOAD (KVA) = 147 x 3 = 441KVA

C) CALCULATING TOTAL MAXIMUM DEMAND LOAD (AMP): I = 441 / (1.732*0.48) I = 530A

MINIMUM SERVICE SIZE: 600A

KEY NOTES:

- 1 ALL ELECTRICAL WORK AND RELATED ACTIVITIES PERFORMED ON-SITE SHALL BE DONE IN ACCORDANCE WITH NATIONAL ELECTRIC CODE (NEC) STANDARDS BEING ENFORCED BY ALL APPLICABLE JURISDICTIONAL REQUIREMENTS AT THE TIME OF CONSTRUCTION.
- UTILITY EQUIPMENT INSTALLATIONS AND PREP WORK SHALL BE COORDINATED WITH THE APPROPRIATE UTILITY ENGINEER AT TIME OF PRECONSTRUCTION MEETING TO ENSURE ACCURACY OF INSTALLATIONS.
- 3 CONDUIT PATHS ARE REPRESENTATIVE ONLY. EXACT CONDUIT PLACEMENT TO BE DETERMINED ON SITE BASED ON FIELD CONDITIONS.
- 4 A NATIONALLY RECOGNIZED TESTING LABORATORY SHALL LIST ALL EQUIPMENT IN COMPLIANCE WITH NEC ARTICLE 110.3
- 5 ALL EXTERIOR EQUIPMENT SHALL BE RAIN TIGHT AND APPROVED FOR USE IN WET CONDITIONS.
- 6 ALL CONDUCTORS TO BE THHN COPPER
- 7 ALL CONDUCTORS AND CABLES SHALL BE PROVIDED WITH STRAIN RELIEF UPON ENTRY INTO ENCLOSURES
- 8 EACH UNGROUNDED CONDUCTOR SHALL BE IDENTIFIED BY PHASE AND SYSTEM PER NEC 210.5
- 9 ALL METALLIC COMPONENTS SHALL BE GROUNDED VIA ELECTRIC GROUNDING CONDUCTORS.
- (10) ALL UNDERGROUND CONDUIT TO BE UL RATED, MINIMUM 24" DEEP.
- WIRING FOR ELECTRICAL VEHICLE CHARGING STATIONS TO BE INSTALLED PER MANUFACTURER'S DIRECTIONS AND SPECIFICATIONS.
- CONTRACTOR TO ENSURE THAT ALL FEEDERS, CONDUITS, CONDUCTORS, OCPD, TRANSFORMERS, ELECTRICAL PANELS AND OTHER ELECTRICAL EQUIPMENT IS SIZED TO COMPLY WITH CURRENT NEC AND LOCAL AHJ CODES.
- CONTRACTOR IS RESPONSIBLE TO VERIFY DESIGN, ENGINEERING ASSUMPTIONS AND EXISTING FIELD CONDITIONS. REPORT ANY INSUFFICIENCIES TO ENGINEER OF RECORD PRIOR TO ANY WORK BEING PERFORMED.
- ELECTRICAL EQUIPEMENT PROVIDING POWER TO DCFC MUST BE IN COMPLIANCE WITH NEC 625.43, READILY ACCESSIBLE LOCATION. THE DISCONNECTING MEANS SHALL BE LOCKABLE OPEN IN ACCORDANCE WITH 110.25.
- (15) GROUNDING INSTALLATION AS PER NEC ART. 250.
- (16) CONTRACTOR TO VERIFY XFMR-EV PHASE VECTORS, CONNECTION AND SECONDARY VOLTAGE PRIOR TO CONSTRUCTION.

FED FROM NEW UTILITY POLE #17983 **PRIMARY** (CONDUIT & CABLE TO BE INSTALLED BY THE CONTRACTOR) XFMR-EV 480Y/277V SECONDARY 3PH - 4W . (16) \bigcap 2 SETS OF 3" CNDT (4) 350KCMIL 1 #2 GEC D/S - MAIN 600A. 3 POLE FUSIBLE 3P /600A SERVICE DISCONNECT 600A 2 SETS OF 3" CNDT (4) 350KCMIL 1 #2 GEC CT CABINET 600A TYPE 3R METER METER 600/5 2 1/2" CNDT - 2 1/2" CNDT (4) 3/0 AWG (4) 3/0 AWG 1 #6 EGC 1 #6 EGC D/S #1 D/S #2 D/S #3 3P / 200A 3P / 200A □ 200A □ 200A 2 1/2" CNDT -- 2 1/2" CNDT (4) 3/0 AWG (4) 3/0 AWG 1 #6 EGC 1 #6 EGC TO DCFC #3 DCFC #1 DCFC #2 (FUTURE INSTLLATION) 120KW 120KW

SINGLE LINE DIAGRAM



SEAL & SIGNATURE:

DURAK

* EVRIM ERCAN

NUMBER

PE-2019023460

01/30/2023

THE ENGINEER OF RECORD SHALL NOT HAVE CONTROL OR CHARGE OF AND SHALL NOT BE RESPONSIBLE FOR CONSTRUCTION MEANS, METHODS, DEVIATIONS, TECHNIQUES, SEQUENCES, OR PROCEDURES, OR FOR SAFETY PRECAUTIONS AND PROGRAMS IN CONNECTION WITH THE WORK, FOR THE ACTS OR OMISSIONS OF THE CONTRACTOR, SUBCONTRACTORS OR ANY OTHER PERSONS PERFORMING ANY OF THE WORK, OR FOR THE FAILURE OF ANY OF THEM TO CARRY OUT THE WORK IN ACCORDANCE WITH THE CONTRACT

THE INFORMATION IN THIS DRAWING IS PROPRIETARY. ANY REPRODUCTION, DISCLOSURE, OR USE THEREOF IS PROHIBITED WITHOUT THE WRITTEN CONSENT OF THE ENGINEER OF RECORD.

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DOCUMENTS.

01/31/2023	ISSUED FOR APPROVA

REV. DATE DESCRIPTION

CLIENT:



ADDRESS: 185 INDUSTRIAL PKWY, BRANCHBURG, NJ 08876

908-801-6890

PROJECT:

EVCS INSTALLATION

ADDRESS: 1735 NORTH BISHOP AVE ROLLA, MO 65401

AMPER PROJECT NUMB	AMPER PROJECT NUMBER:			
1626				
SHEET SIZE:	DRAWN BY:			
24X36	IB			
DESIGNED BY:	CHECKED BY:			

DEE

SHEET TITLE:
SINGLE LINE DIAGRAM &

LOAD CALCULATION

SHEET NO

AC

EV04



DCFC OVERVIEW




600A FUSIBLE DISCONNECT SCALE: NTS








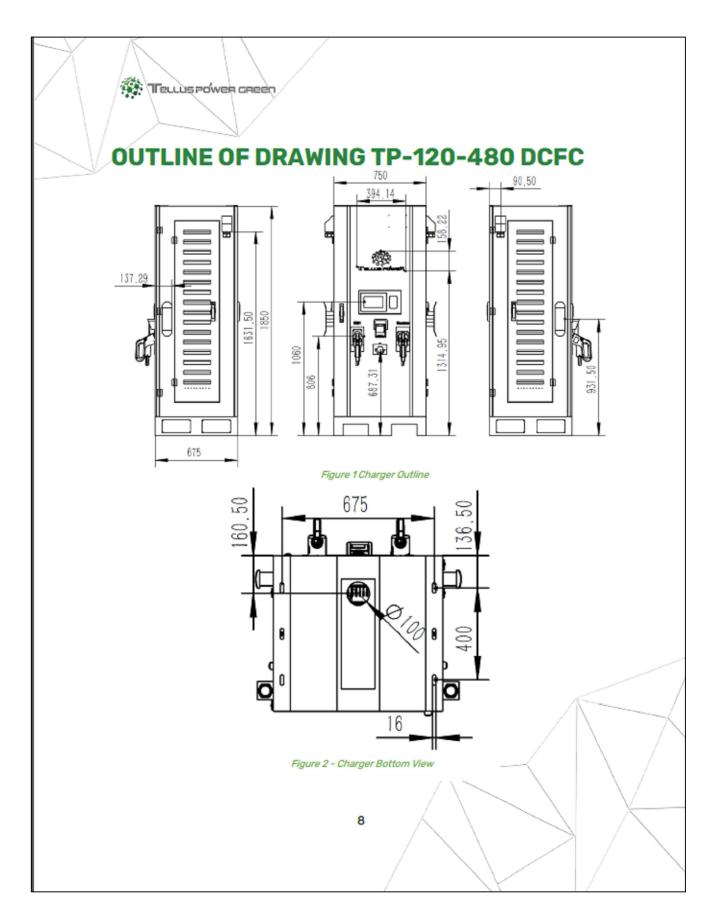

3 DCFC DIMENSIONS

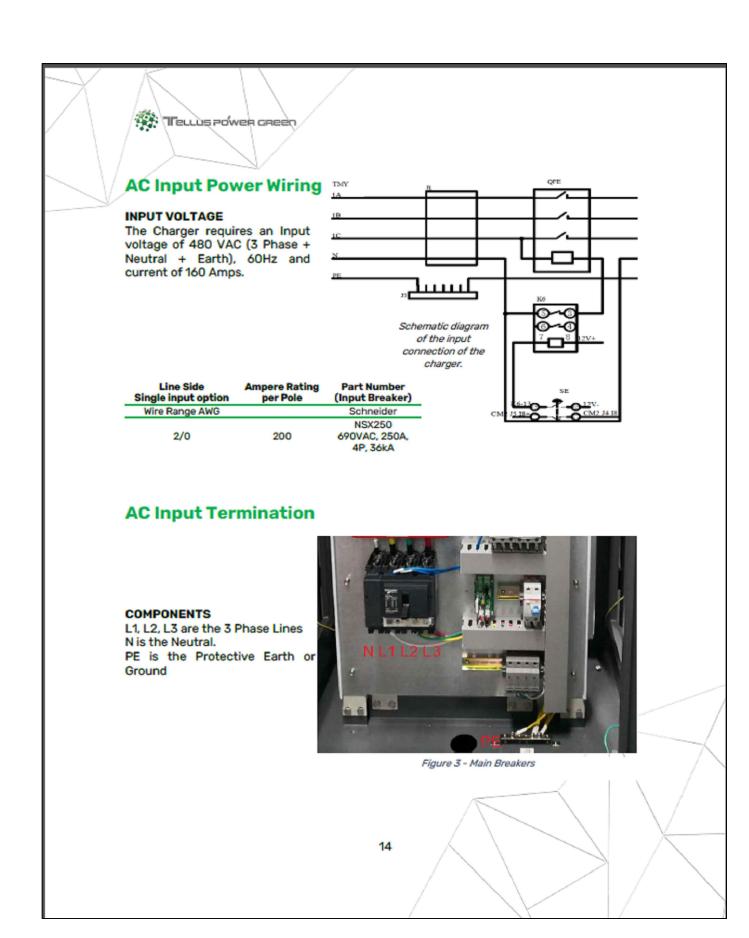





PROFESSIONAL ENGINEERING

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1735 NORTH BISHOP AVE **ROLLA, MO 65401**

AMPER PROJECT NUMB	ER:
1626	
SHEET SIZE:	DRA

AWN BY: 24X36 CHECKED BY: DESIGNED BY: DEE

SHEET TITLE: DATA SHEETS

EV09